

KIER + WRIGHT PROJECT NUMBER: A24193-1

3436


XTRA SPACE STORAGE DR XTRA SPACE SPECIAL USE PERMIT
OF
EXTRA SPACE STORAG
FOR
EXTRA SPACE

EXTRA SPACE STORAGE 3436 -NEW BUILDING HIGH POINT OAKS ADDITION LOTS 3R-1 & 3R-2, BLOCK C 5.798 ACRES ZONING: LIGHT INDUSTRIAL

USE: SELF SERVICE STORAGE

DRAWING NUMBER:

C1.0 1 OF 12 SHE

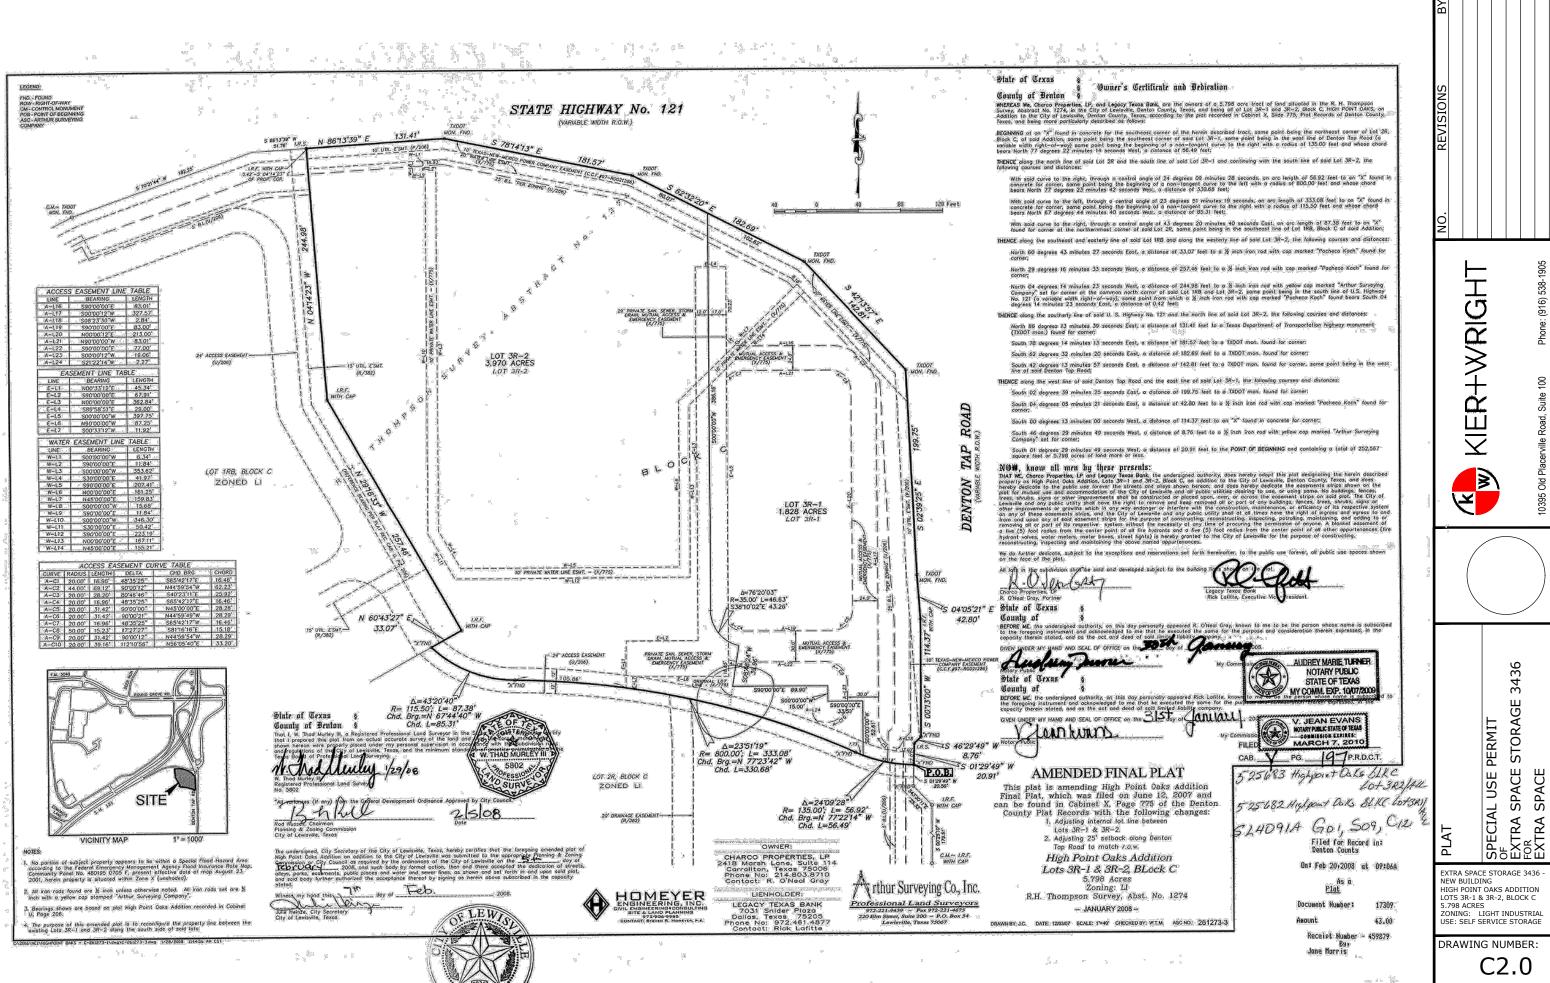


KIER + WRIGHT PROJECT NUMBER: A24193-1

DRAWING NUMBER: C2.0

SPACE

SPACE

2 OF 12 SHE

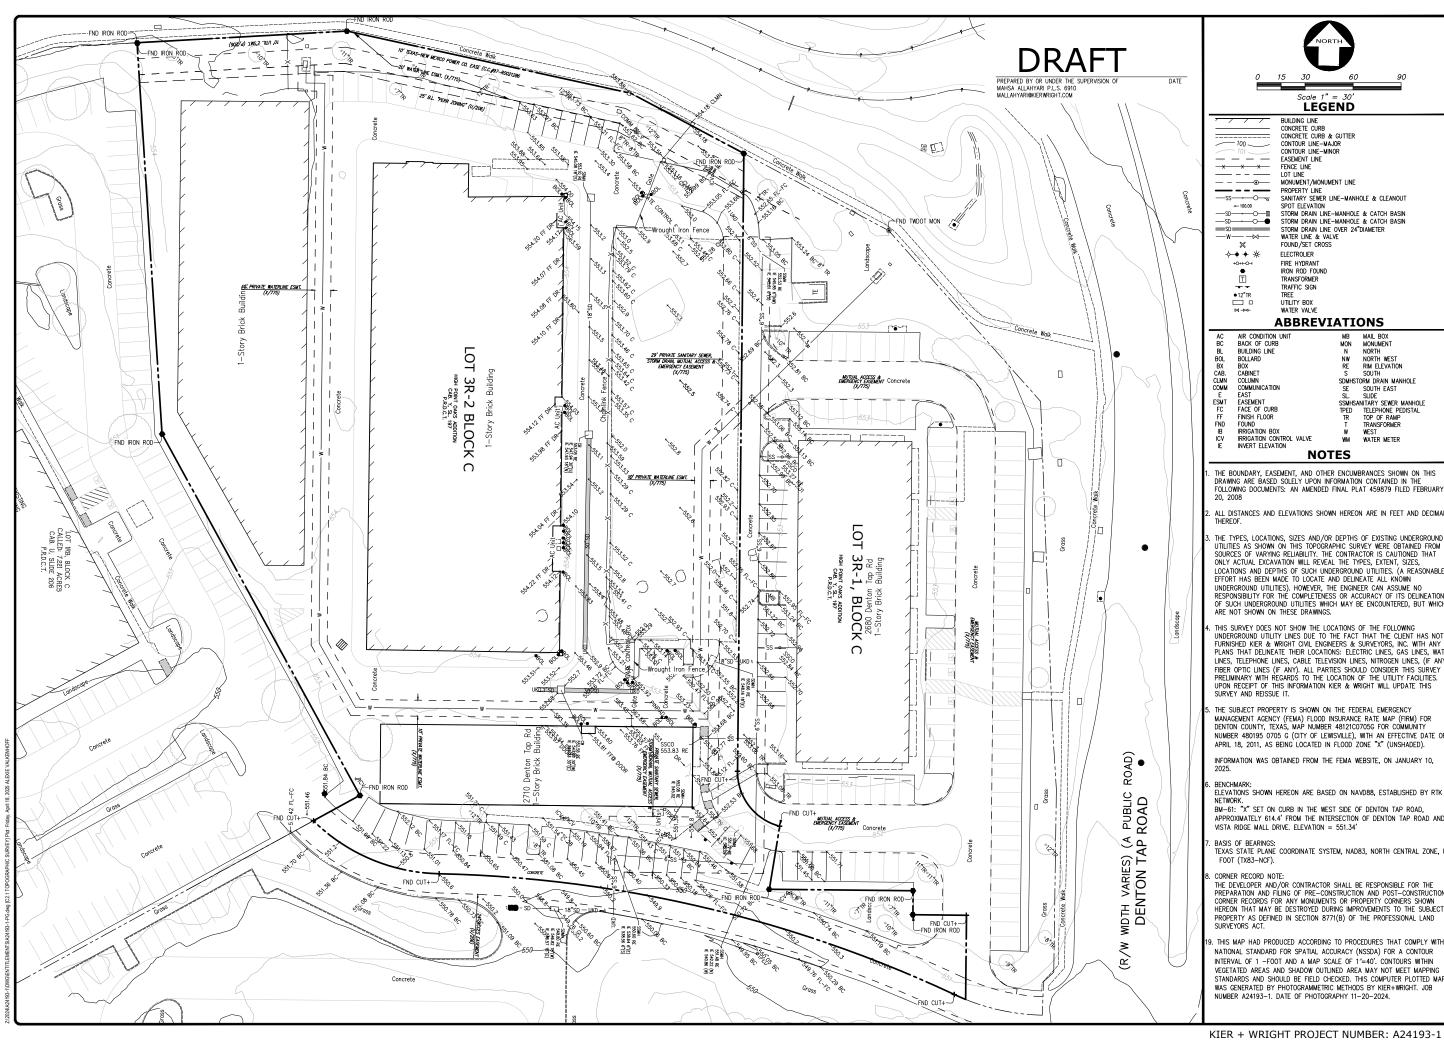



BUILDING LINE
CONCRETE CURB
CONCRETE CURB & GUTTER
CONTOUR LINE—MAJOR CONTOUR LINE-MINOR FENCE LINE
LOT LINE
MONUMENT/MONUMENT LINE PROPERTY LINE
SANITARY SEWER LINE-MANHOLE & CLEANOUT SPOT ELEVATION
STORM DRAIN LINE—MANHOLE & CATCH BASIN
STORM DRAIN LINE—MANHOLE & CATCH BASIN
STORM DRAIN LINE OVER 24"DIAMETER WATER LINE & VALVE FOUND/SET CROSS FIRE HYDRANT IRON ROD FOUND

ABBREVIATIONS

MB MAIL BOX
MON MONUMENT
N NORTH
NW NORTH WEST
RE RIM ELEVATION
S SOUTH
SDMHSTORM DRAIN MANHOLE
SE SOUTH LAST SOMESTORM DRAIN MANHOLE
SE SOUTH EAST
SL. SLIDE
SSMESANTARY SEWER MANHOLE
TPED TELEPHONE PEDISTAL
TR TOP OF RAMP
T TRANSFORMER
W KEST
WM WATER METER

NOTES

THE BOUNDARY, EASEMENT, AND OTHER ENCUMBRANCES SHOWN ON THIS DRAWING ARE BASED SOLELY UPON INFORMATION CONTAINED IN THE FOLLOWING DOCUMENTS: AN AMENDED FINAL PLAT 459879 FILED FEBRUARY

ALL DISTANCES AND ELEVATIONS SHOWN HEREON ARE IN FEET AND DECIMALS THEREOF.

THE TYPES, LOCATIONS, SIZES AND/OR DEPTHS OF EXISTING UNDERGROUND UTILITIES AS SHOWN ON THIS TOPOGRAPHIC SURVEY WERE OBTAINED FROM SOURCES OF VARYING RELIABILITY. THE CONTRACTOR IS CAUTIONED THAT ONLY ACTUAL EXCAVATION WILL REVEAL THE TYPES, EXTENT, SIZES, LOCATIONS AND DEPTHS OF SUCH UNDERGROUND UTILITIES. (A REASONABLE EFFORT HAS BEEN MADE TO LOCATE AND DELINEATE ALL KNOWN UNDERGROUND UTILITIES). HOWEVER, THE ENGINEER CAN ASSUME NO RESPONSIBILITY FOR THE COMPLETENESS OR ACCURACY OF ITS DELINEATION OF SUCH UNDERGROUND UTILITIES WHICH MAY BE ENCOUNTERED, BUT WHICH ARE NOT SHOWN ON THESE DRAWINGS.

THIS SURVEY DOES NOT SHOW THE LOCATIONS OF THE FOLLOWING UNDERGROUND UTILITY LINES DUE TO THE FACT THAT THE CUENT HAS NOT FURNISHED KIER & WRIGHT CIVIL ENGINEERS & SURVEYORS, INC. WITH ANY PLANS THAT DELINEATE THEIR LOCATIONS: ELECTRIC LINES, GAS LINES, WATER LINES, TELEPHONE LINES, CABLE TELEVISION LINES, NITROGEN LINES, (IF ANY) FIBER OPTIC LINES (IF ANY). ALL PARTIES SHOULD CONSIDER THIS SURVEY AS PRELIMINARY WITH REGARDS TO THE LOCATION OF THE UTILITY FACILITIES. UPON RECEIT OF THIS INFORMATION KIER & WRIGHT WILL UPDATE THIS SURVEY AND REISSUE IT.

. THE SUBJECT PROPERTY IS SHOWN ON THE FEDERAL EMERGENCY MANAGEMENT AGENCY (FEMA) FLOOD INSURANCE RATE MAP (FIRM) FOR DENTON COUNTY, TEXAS, MAP NUMBER 48121C0705G FOR COMMUNITY NUMBER 480195 0705 G (CITY OF LEWISVILLE), WITH AN EFFECTIVE DATE OF APRIL 18, 2011, AS BEING LOCATED IN FLOOD ZONE "X" (UNSHADED).

INFORMATION WAS OBTAINED FROM THE FEMA WEBSITE, ON JANUARY 10,

BM-61: "X" SET ON CURB IN THE WEST SIDE OF DENTON TAP ROAD, APPROXIMATELY 614.4' FROM THE INTERSECTION OF DENTON TAP ROAD AND VISTA RIDGE MALL DRIVE. ELEVATION = 551.34'

BASIS OF BEARINGS: TEXAS STATE PLANE COORDINATE SYSTEM, NAD83, NORTH CENTRAL ZONE, US

THE DEVELOPER AND/OR CONTRACTOR SHALL BE RESPONSIBLE FOR THE PREPARATION AND FILING OF PRE-CONSTRUCTION AND POST-CONSTRUCTION CORNER RECORDS FOR ANY MONUMENTS OR PROPERTY CORNERS SHOWN HEREON THAT MAY BE DESTROYED DURING IMPROVEMENTS TO THE SUBJECT PROPERTY AS DEFINED IN SECTION 8771(B) OF THE PROFESSIONAL LAND SURVEYORS ACT.

. THIS MAP HAD PRODUCED ACCORDING TO PROCEDURES THAT COMPLY WITH NATIONAL STANDARD FOR SPATIAL ACCURACY (NSSDA) FOR A CONTOUR INTERVAL OF 1 -FOOT AND A MAP SCALE OF 1"=40'. CONTOURS WITHIN VEGETATED AREAS AND SHADOW OUTLINED AREA MAY NOT MEET MAPPING STANDARDS AND SHOULD BE FIELD CHECKED. THIS COMPUTER PLOTTED MAP WAS GENERATED BY PHOTOGRAMMETRIC METHODS BY KIER+WRIGHT. JOB NUMBER A24193-1. DATE OF PHOTOGRAPHY 11-20-2024.

KIER+WRIGHI

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3436 XTRA SPACE STORAGE PERMIT


SURVEY


SPECIAL USE POF OF EXTRA SPACE SEXTRA SPACE EXTRA SPACE STORAGE 3436 -NEW BUILDING HIGH POINT OAKS ADDITION LOTS 3R-1 & 3R-2, BLOCK C 5.798 ACRES ZONING: LIGHT INDUSTRIAL

USE: SELF SERVICE STORAGE

DRAWING NUMBER:

C2.1 2 OF 12 SHE

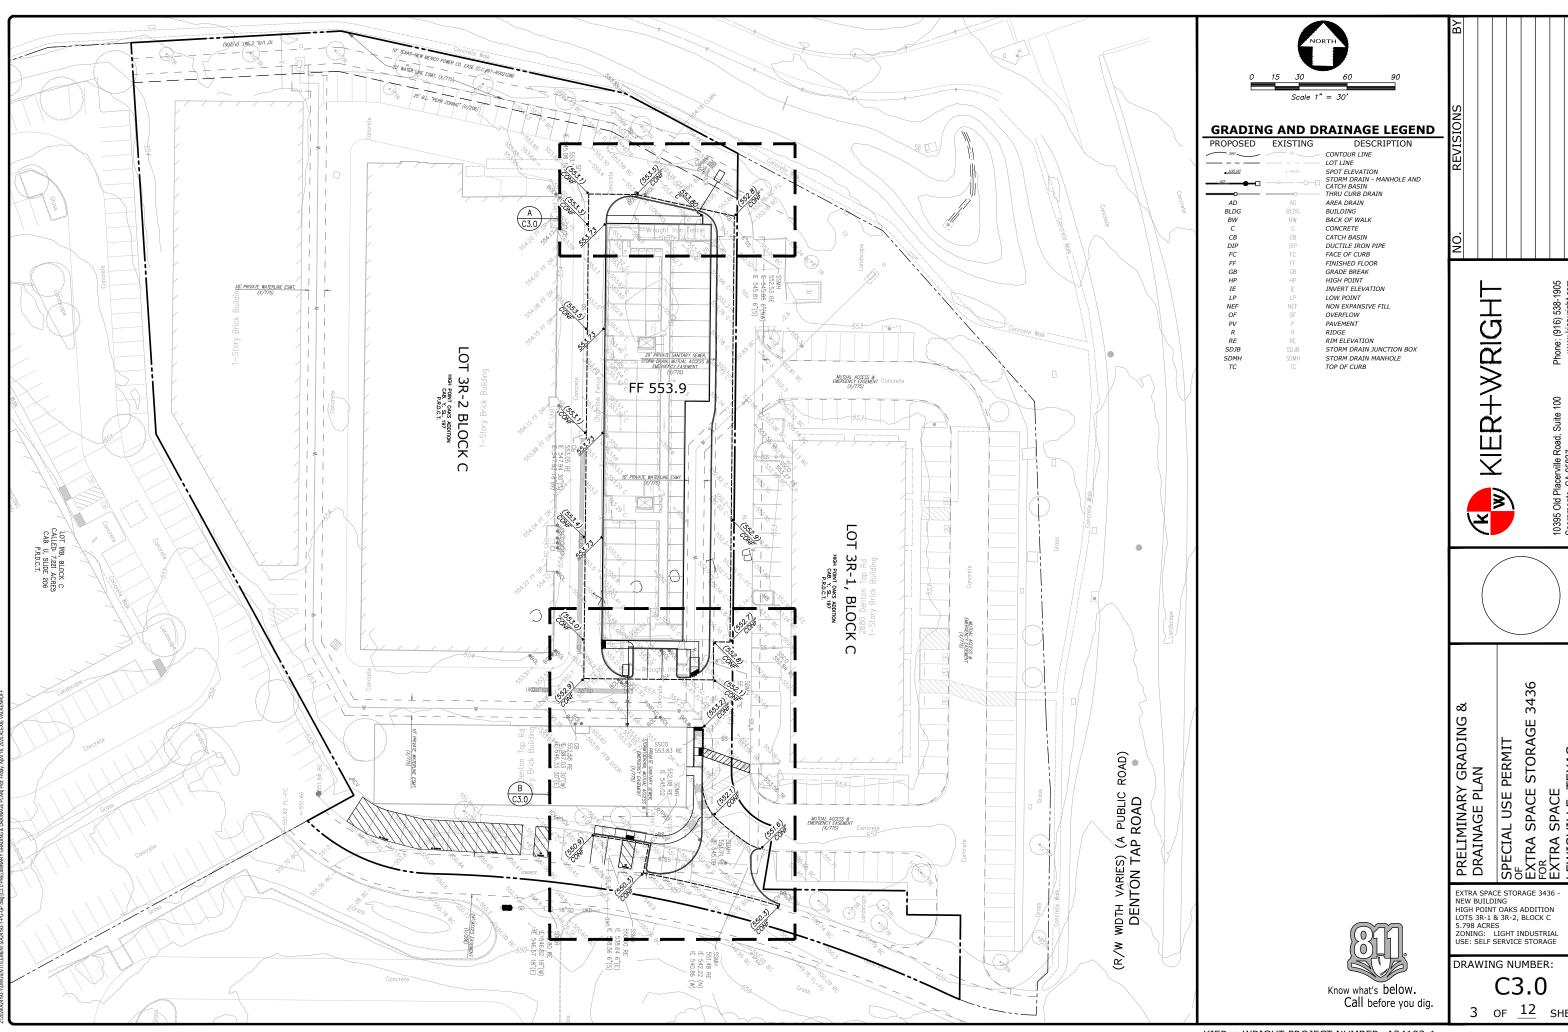


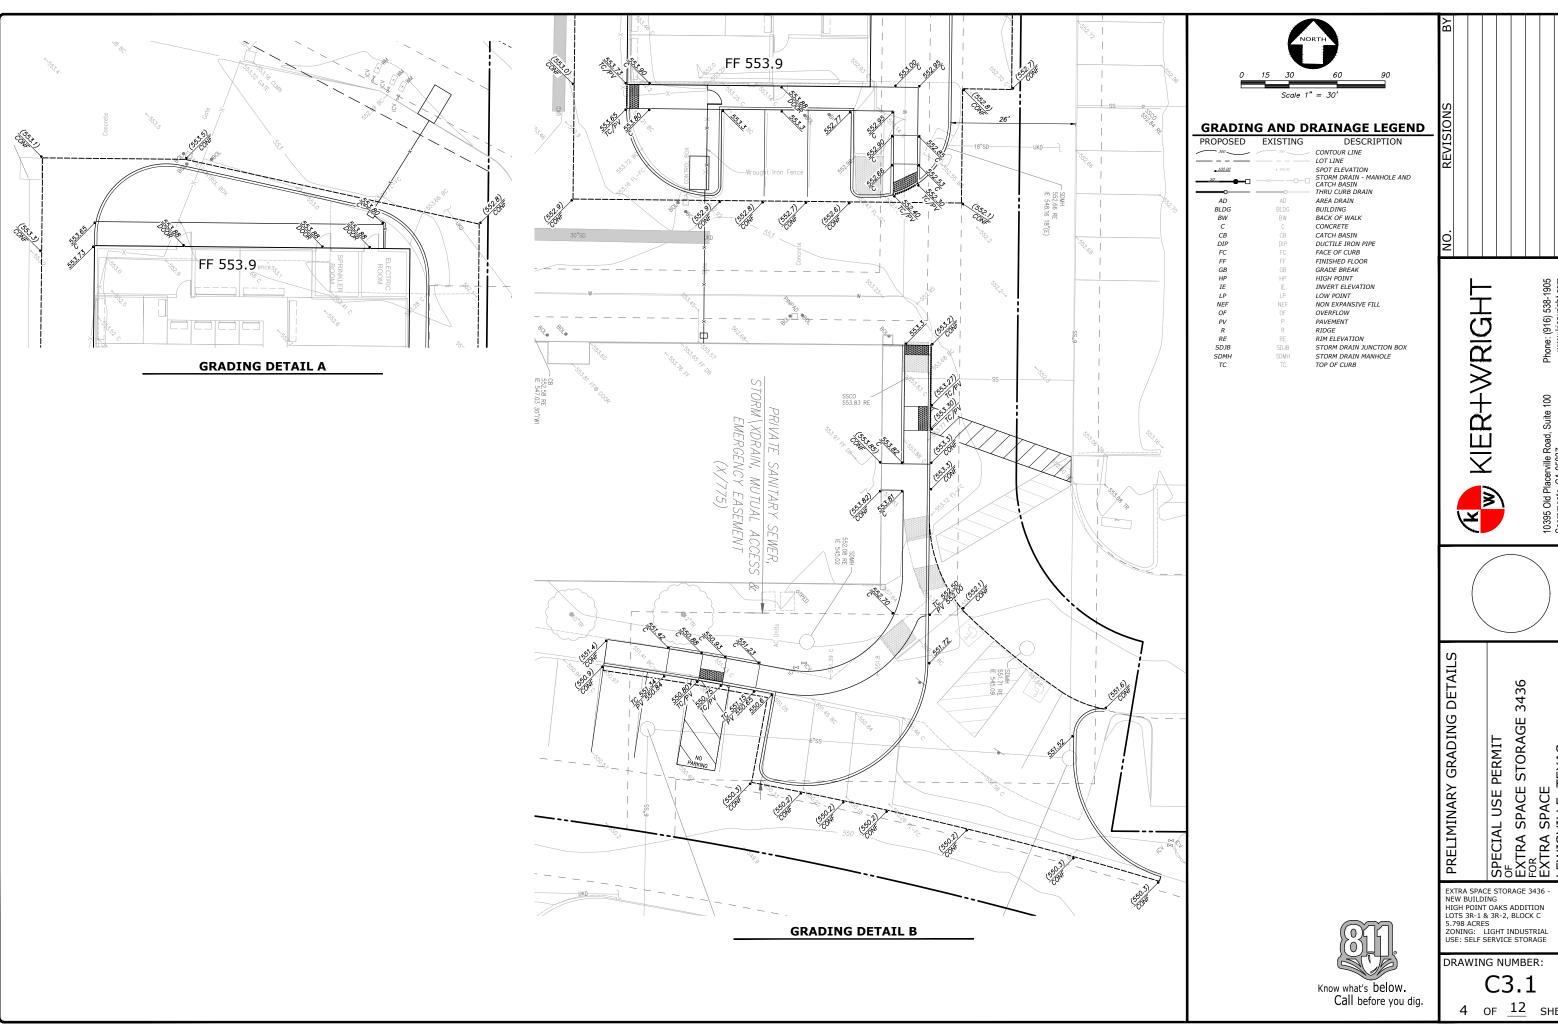

KIER + WRIGHT PROJECT NUMBER: A24193-1

DRAWING NUMBER:

C3.1

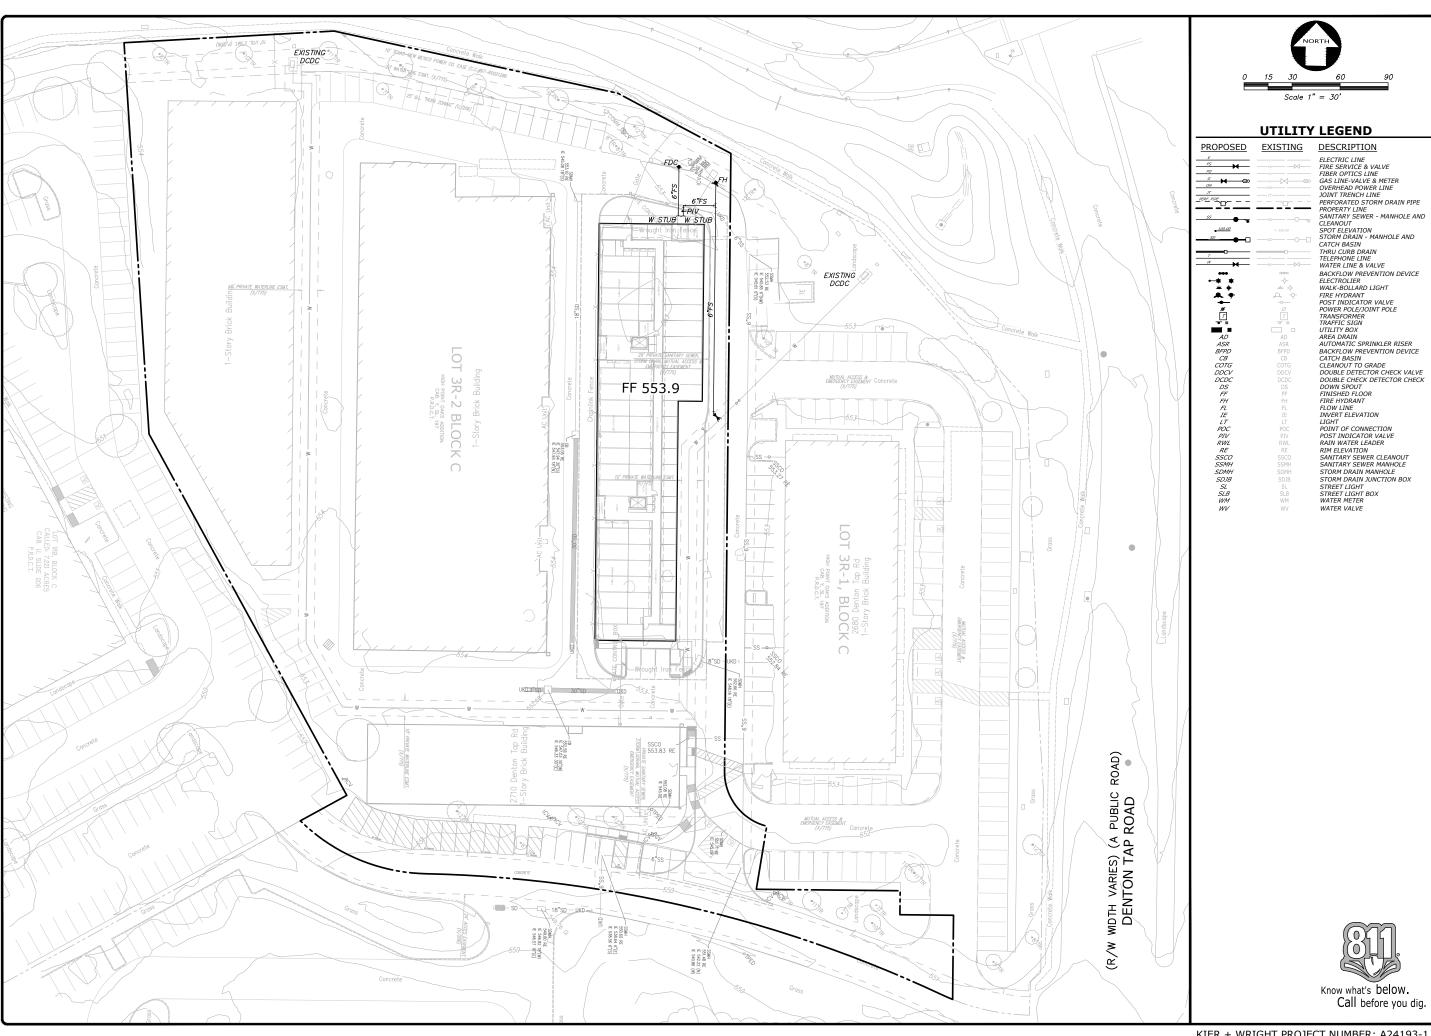

EXTRA SPACE STORAGE 3436 - NEW BUILDING
HIGH POINT OAKS ADDITION
LOTS 3R-1 & 3R-2, BLOCK C
5.798 ACRES
ZONING: LIGHT INDUSTRIAL
USE: SELF SERVICE STORAGE DRAWING NUMBER:

PRELIMINARY UTILITY PLAN


C4.0

SPECIAL USE PERMIT
OF
EXTRA SPACE STORAGE 3436
FOR
EXTRA SPACE

KIER+WRIGHT

X

5 OF 12 SHE

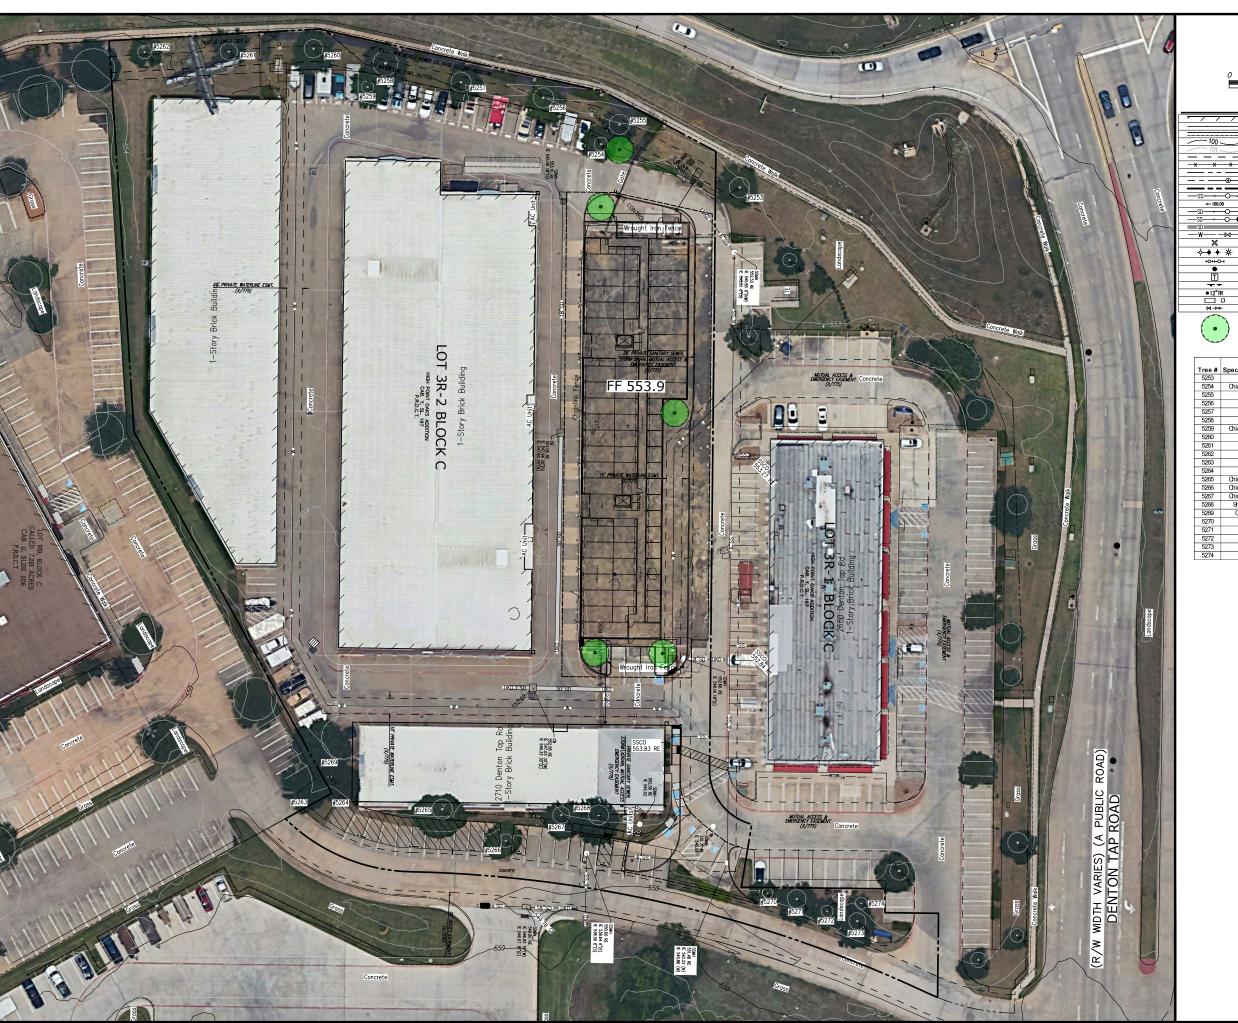



	Scale 7 = 30	
	LEGEND	EVISIONS
, , , , , , , , , , , , , , , , , , , 	BUILDING LINE	
	CONCRETE CURB	\odot
	CONCRETE CURB & GUTTER	77
100	CONTOUR LINE-MAJOR	124
101	CONTOUR LINE-MINOR	
	EASEMENT LINE	ш
-x x x	FENCE LINE	\propto
	LOT LINE	
_ •	MONUMENT/MONUMENT LINE	
	PROPERTY LINE	
—ss——o—	SANITARY SEWER LINE-MANHOLE & CLEANOUT	
← 100.00	SPOT ELEVATION	
—SD——O— II	STORM DRAIN LINE-MANHOLE & CATCH BASIN	
—SD—— ○ —●	STORM DRAIN LINE-MANHOLE & CATCH BASIN	
—SD———	STORM DRAIN LINE OVER 24"DIAMETER	
—w——w—	WATER LINE & VALVE	$\overline{}$
×	FOUND/SET CROSS	131
♦ ♦ *	ELECTROLIER	
+0+1-0-1	FIRE HYDRANT	
•	IRON ROD FOUND	
T	TRANSFORMER	
	TRAFFIC SIGN	

NEW TREE, SEE LANDSCAPE PLANS

				Protected or
Tree #	Species - Common	Species - Scientific	DBH (in.)	Removed
5253	Live Oak	Quercus virginiana	14	Protected
5254	Chinese Pistache	Pistacia chinensis	9	Protected
5255	Live Oak	Quercus virginiana	11.5	Protected
5256	Live Oak	Quercus virginiana	13.5	Protected
5257	Live Oak	Quercus virginiana	14	Protected
5258	Live Oak	Quercus virginiana	16	Protected
5259	Chinese Pistache	Pistacia chinensis	9	Protected
5260	Live Oak	Quercus virginiana	12.5	Protected
5261	Live Oak	Quercus virginiana	10.5	Protected
5262	Live Oak	Quercus virginiana	9	Protected
5263	Bur Oak	Quercus macrocarpa	15	Protected
5264	Live Oak	Quercus virginiana	13.5	Protected
5265	Chinese Pistache	Pistacia chinensis	13.5	Protected
5266	Chinese Pistache	Pistacia chinensis	10	Protected
5267	Chinese Pistache	Pistacia chinensis	11.5	Protected
5268	Shumard Oak	Quercus shumardii	10	Protected
5269	Chinese ⊞ m	Ulmus parvifolia	15	Protected
5270	Red Oak	Quercus rubra	7.5	Protected
5271	Live Oak	Quercus virginiana	12	Protected
5272	Red Oak	Quercus rubra	8.5	Protected
5273	Live Oak	Quercus virginiana	16.5	Protected
5274	Red Oak	Quercus rubra	7	Protected







SPECIAL USE PERMIT
OF
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TREE EXHIBIT

EXTRA SPACE STORAGE 3436 -NEW BUILDING HIGH POINT OAKS ADDITION LOTS 3R-1 & 3R-2, BLOCK C 5.798 ACRES ZONING: LIGHT INDUSTRIAL USE: SELF SERVICE STORAGE

DRAWING NUMBER:

C5.0 6 OF 12 SHE



ELEVATION COLOR AND KEY NOTES FIES SMOOTH FINISH NEBULOUS WHITE COLOR SPLIT FACE CMU BLOCK LIGHT TAN (MATCH EXISTING) E-3 E-4 NOT USED E-5 PRE-FINISHED METAL GUTTER/TRIM CITYSCAPE COLOR E-6 PRE-FINISHED METAL DOWN SPOUT E-7 METAL DOOR MATCH TAN CMU COLOR E-8 PRE-FINISHED ALUMINUM CANOPY IRON ORE COLOR E-9 STOREFRONT GLASS WITH FAUX DOOR CLEAR ALUMINUM E-10 STOREFRONT WITH METAL PANEL CLEAR ALUMINUM E-11 12' AUTO BI-PARTING DOOF CLEAR ALUMINUM E-12 CUSTOMER ROLL-UP DOOR E-13 METAL ROOF E-14 LED WALL LIGHT E-15 E.S.S. CHANNEL LETTERS COLOR: REFER TO RENDERINGS E-16 LOADING CHANNEL LETTERS COLOR: BLACK

Extraspace Storage.

EXTRA SPACE STORAGE, Inc.
2795 E COTTONWOOD PARKWAY, SUITE 400, SALT LAKE CITY, UTAH 84121

PROJECT CONTACT

NAME: STEWART HANDLEY PHONE: -

EMAIL: shandley@extraspace.com

CONTACT ADDRESS

EXTRA SPACE STORAGE, Inc.. CORPORATE OFFICE 2795 E COTTONWOOD PARKWAY, SUITE 400, SALT LAKE CITY, UTAH 84121

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EXTRA SPACE STORAGE 3436 -NEW BUILDING HIGH POINT OAKS ADDITION LOTS 3R-1 & 3R-2, BLOCK C 5.798 ACRES ZONING: LIGHT INDUSTRIAL USE: SELF SERVICE STORAGE

PROJECT LOCATION

LIFE STORAGE 2710 DENTON TAP ROAD, LEWISVILLE, TX 75067

DATE

01-17-2025

SHEET TITLE

PROPOSED ELEVATIONS

SHEET NUMBER

A-102

AVERAGE MASONRY COVERAGE = 82.8%

THESE DRAWINGS ARE FOR REFERENCE USE ONLY AND ARE NOT FOR CONSTRUCTION. ARCHITECT TO USE THESE DRAWINGS FOR REFERENCE ONLY. ARCHITECT/ENGINEER IS RESPONSIBLE FOR VERIFYING ALL DIMENSIONS AND CODE REQUIREMENTS AS REQUIRED BY LOCAL JURISDICTIONS.

01 PROPOSED ELEVATIONS A-102 SCALE: N.T.S.

GENERAL PLANTING NOTES

- 1. Contractor shall be responsible for becoming aware of all existing conditions, utilities, pipes and structures, etc. related to the project prior to bidding and construction. The Contractor shall be held responsible for contacting all utility companies for locating all underground utility lines, including depths, prior to any excavation. The Contractor shall notify the Owner's representative of apparent conflicts with construction and utilities so that adjustments can be planned prior to installation. Contractor shall take sole responsibility for any and all cost or other liabilities incurred due to damage of said
- 2. The Contractor shall not willfully proceed with construction as designed when it is apparent that unknown obstructions and/or grade differences exist that may not have been known during design. Such conditions shall be immediately brought to the attention of the Owner's Representative for clarification. The Contractor shall assume full responsibility for all liabilities, including necessary revisions due to failure to give such notification
- 3. Contractor shall be responsible for coordination with subcontractors and other contractors of related trades as required to
- 4. The acceptable tolerances for this project are minimal and specific layout is required as shown on the layout, planting and other plans. Final location and staking of all plant materials shall be accepted by the Owner's Representative in advance of beginning installation of all plant materials.
- 5. Coordinate installation of all plant materials with other ongoing work on the project, including but not limited to irrigation, pavements, curb and related constructions. Any damage to existing improvements is the responsibility of said Contractor. The contractor shall notify the owner of the damages and shall be responsible for all repairs.
- 6. Contractor shall notify Owner's Representative 48 hours prior to commencement of work to coordinate project inspection
- 7. The Contractor shall take all necessary scheduling and other precautions to avoid climatic damage to plants. A "planting" of specific calendar days is required to be submitted by the Contractor for approval and planting operations should occur per
- 8. If conflicts arise between site conditions or size of areas and scaled plans, Contractor is required to contact Owner's Representative for resolution. Failure to make such conflicts known to the Owner's Representative will result in Contractor's liability to relocate the materials
- 9. Plant names may be abbreviated on the drawings. See plant legend for symbols, abbreviations, botanical/common names, sizes, estimated quantities (if given) and other ren
- 10. It is the Contractor's responsibility to furnish all plant materials free of pests or plant diseases. Pre-selected or "tagged" material must be inspected by the Contractor and certified pest and disease free. It is the Contractor's obligation to maintain and warranty all plant materials per the specifications. All plants shall be subject to Owner's approval prior to installation.
- 11. Where provided, area takeoffs and plant quantity estimates in plant list are for information only. Contractor is responsible to do their own quantity take-offs for all plant materials and sizes shown on plans. In case of any discrepancies, plans take precedence over call-outs and/or the plant list(s). 12. Contractor shall provide "per-unit costs" for every size of plant material, and by type, as called out on Planting Plans in the
- Bid Proposal. Unit cost to include the plant material itself and installation, including all labor, amendments, fertilizers, warranty, etc., as detailed and specified for each size, "complete in place". 13. The Contractor is responsible to restore all areas of the site, or adjacent areas, where disturbed by operations of or related
- to the Contractor's work. Sod areas disturbed shall be restored with new sod. Native areas disturbed, if not already improved to meet other requirements of this contract, shall be restored consistent with type, rates and species of existing 14. During plant establishment, native and wetland areas shall be protected from sedimentation and erosion. Prior to
- construction activities, native and wetland areas outside of the project limits shall be protected with silt fence. Any such disturbance will require full restoration to natural pre-construction conditions at the contractors expense.
- 15. When planting trees and shrubs in existing natural areas, minimize disturbance to adjacent existing vegetation. Any such urbance will require full restoration to natural pre-construction conditions at the contractors expen
- 16. No Ball & Burlap (B&B) material is allowed or accepted unless specifically specified in the plans or approved through a formal submittal by the Landscape Architect
- All plants shall be nursery grown, Grade 1 plants meeting American Nursery and Landscape Association (ANLA) standards set forth in the "American Standard for Nursery Stock" (ANSI Z60.1-2004). Plants are to be typical in shape and size for species. Plants shall not be root-bound or loose in their containers. Handle all plants with care in transporting, planting and nce until inspection and final acceptance.
- 18. Warranty: Provide a minimum one-year replacement warranty for all plant materials. Warranty shall cover plants which have died or partially died (thereby ruining their natural shape), but shall not include damage by vandalism, browsing, hail, abnormal freezes, drought or negligence by the Owner. The Warranty is intended to cover Contractor negligence, infestations, disease and damage or shock to plants. Plants replaced under Warranty will be warranted for one year
- 19. The Contractor is responsible for all maintenance of the site for the duration of construction until acceptance
- 20. The Contractor shall provide a 90-day maintenance period after completion of all scope elements

PLANTING LAYOUT AND INSTALLATION

- 1. The Contractor shall be responsible for accurately laying out the plant beds and lawn areas by scaling the Drawings. The Contractor shall provide paint lines/stakes/hose or other means to fully indicate the specific layout geometry of all bed lines for approval by Owner's Representative prior to installation. The Contractor's Base Bid shall anticipate minor adjustments as directed by the Landscape Architect in the field. Changes affecting quantities will be covered by unit prices.
- 2. Following the approval of layout, the Contractor shall closely coordinate the installation of the irrigation system to conform
- 3. All planting beds are to be separated from adjacent Turf Sod, Turf Seed and Native Seed areas with edging per specifications and details. Additional locations may be indicated on the Drawings. Install edging following manufacture's installation instructions. Maintain an accurate layout with smooth curves and transitions, free of kinks and abrupt bends. Top of edging is to be 1" above soil level of adjacent turf. In Bid Proposal furnish a unit price per linear foot of edging installed
- 4. Provide matching sizes and forms for all species of trees and plants installed on grid or spaced equally in rows as shown on drawings. Adjust spacing (to "equal-equal") as necessary, subject to acceptance by the Owner's Representative
- 5. Unless otherwise indicated:
- a. All groupings of groundcovers, perennials, ornamental grasses and annuals shall be triangularly spaced (equal-equal). b. All planting areas including sod, seed and planting beds, shall receive soil amendments per the notes and specifications.
 c. Sodded lawn shall have been grown between 9 and 18 months and shall be vigorous, well-rooted and healthy turf. Minimum thatch thickness shall be %". d. All bulb planting shall occur after mid-October and before ground is frozen. See details for bulb planting layout
- 6. All gravel areas or rock mulches should be installed over weed barrier fabric. Edges of weed barrier should overlap minimum 6". Gravel depth shall be a minimum of 3" deep, or as indicated in the plan details.
- All Plant Beds and pit planted plants shall receive a 3" depth layer of shredded hardwood mulch. Refer to plans, details and specifications for location and type of any alternate mulch used. In Bid Proposal furnish a unit price(s) per cubic yard of mulch(es) placed. This unit price(s) will be used in the adjustment of bed areas.
- 8. Planting pits for 1 and 5 gallon shrubs shall be at least 8" larger in diameter than the container size. Larger container sizes and B&B plants shall be planted in pits at least 3 times larger in diameter than the root ball size.
- 9. Plants shall be installed to present their best side facing the viewer
- 10. Owner's representative shall have final approval of plant material layout.

AUTOMATIC IRRIGATION SYSTEM GENERAL NOTES:


1. Obtain all permits and licenses applicable prior to the start of work.

2. All required landscape areas shall be irrigated per applicable local ordinances and tceq regulations.


- 3. Drip irrigation shall be placed in accordance with manufacturer recommendations, extend drip lines to irrigate planting adjacent
- a. Maximum drip lateral length shall not exceed manufacturer specifications
- 4. Any quantities shown are approximate. verify quantities and provide all labor, materials, and devices necessary to complete the
- 5. The layout shown is diagrammatic. do not place lines or devices in the critical root zone of any tree, or in pavement areas, or areas that conflict with proper installation and function of the system.
- - a. Verify and mark the location of all on-site utilities which might be affected by the irrigation system.
- b. Verify and mark the location of all buried cables, conduits, piping, etc. prior to trenching or digging, call as 811 per Texas utilities code title 5 chapter 251 underground facility damage pr
- c. Adjust the design as necessary, together with the licensed irrigator, and owners, to suit site conditions, elevations and
- d. Protect from damage as necessary, existing property, existing landscape features, plant material, structures, this work in progress, and the work of other trades.
- 7. Provide professional grade valve boxes large enough to accommodate valves and other devices shown in the details. box extensions may be required, ground boxes shall be constructed of materials sufficient in strength to accept loads (pedestrian or vehicular) required based on actual installation location
- 8. Pressure regulating component(s) shall be required where static pressure exceeds manufacturer's recommended operating
- 9. See details for other required materials and devices.
- 10. Piping and fittings:
- a. Mainline irrigation system piping 3" and larger shall be bell & gasketed schedule 40 pvc pipe. lateral irrigation system piping 3" and larger shall be bell & gasketed schedule 40 pvc pipe.
- b. All piping shall utilize thrust blocks at pipe connections per details, where leemco fitting/joint restraints are used thrust
- c. All pipes and electrical bundles passing beneath driveways or paved areas must be sleeved with schedule 40 pvc pipe with nt welded joints. sleeve diameter must equal twice that of the pipe or sized as shown on plans. solvent welded joints.
 - d. All pvc pipe fittings shall be primed with a colored primer, prior to applying pvc cent
 - e. Irrigation mainline and laterals 4" and larger shall utilize leemco fittings/joint restraints as per manufacturer specifications.
 - f. All lateral pipe shall buried to a min. depth of 6"
 - g. All mainline pipe shall be buried to a depth of 18", where conditions prohibit this depth, a min. depth of 6" may be used when approved by the licensed irrigator

- a. Excavate to depths required to provide 4" depth of sand bedding for piping when rock or other unsuitable bearing materials
- b. Excavate trenches and install piping and fill during the same working day, do not leave open trenches or partially filled
- 12. Irrigation controller and system shall be equipped with an evapotranspiration rain/freeze shutoff.
 - a. Irrigation controller shall be equipped with a flow senso
 - b. irrigation controller shall be programmed prior to project closeout.
- 13. Backflow prevention devices:

 - b. Adequate insulation must be provided to protect against freeze
- 14. Contractor shall provide a minimum of a 1- year warranty on all craftsmanship parts, materials and overall irrigation system within the original scope of work

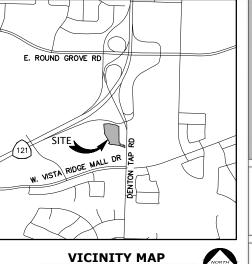



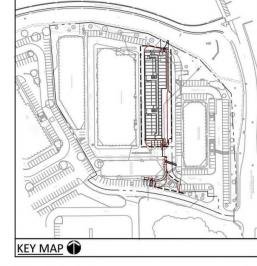

CODE	QTY	BOTANICAL / COMMON NAME	CONTAINER	CALIPER	HT/SPD	WATER USE
	-			, , , , , , , , , , , , , , , , , , , ,	,,,,,,,,,,,,,,,,,,,,,,,,,,,,,,,,,,,,,,,	, , , , , , , , , , , , , , , , , , , ,
TREES QULA	2	Quercus laceyl / Lacey Oak	Container Grown	3°Cal	12-15 H X 8 Spd	TL.
QUVI	3	Quercus virginiana / Southern Live Oak	Container Grown	3°Cal	12-15 H X 8 Spd	L
CODE	QTY	BOTANICAL / COMMON NAME	CONTAINER	CONTAINER SIZE	NOTES	WATER USE
		BOTANICAL / COMMON NAME	CONTAINER	CONTAINER SIZE	NOTES	WATER USE
CODE SHRUBS		BOTANICAL / COMMON NAME	CONTAINER Container Grown	CONTAINER SIZE	NOTES	WATER USE
SHRUBS	3					
SHRUBS	26	llex vomitoria Nana / Dwarf Yaupon	Container Grown	5 gallon	Full	L
SHRUBS LVN MYDD	26 45	liex vomitoria Nana / Dwart Yaupon Myrica cerifera Dons Dwart / Dons Dwart Wax Myrtie	Container Grown	5 gallon 5 gallon	Full Full to Ground	L-M
SHRUBS ILVN MYDD RHIC RHVI	26 45 27 3	llex vomitoria Nana / Dwarf Yaupon Myrica cerifera Dons Dwarf / Dons Dwarf Wax Myrtie Rhaphiolepis Indica Conor / Beanor Tabor Indian Hawthorn	Container Grown Container Grown Container Grown	5 gallon 5 gallon 5 gallon	Full Full to Ground Full	L-M LV
SHRUBS LVN MYDD RHIC	26 45 27 3	llex vomitoria Nana / Dwarf Yaupon Myrica cerifera Dons Dwarf / Dons Dwarf Wax Myrtie Rhaphiolepis Indica Conor / Beanor Tabor Indian Hawthorn	Container Grown Container Grown Container Grown	5 gallon 5 gallon 5 gallon	Full Full to Ground Full	L L-M LV

TURF GRASS/ PLANT BEDS					
NAME	TOTAL	UNITS	DESCRIPTION		
Plant Bed	1,277	sf			
	24	су	Planting mix	6" depth (Pro-Gro Soil Mix by Whittlesey Landscape Suppl or approved equal)	
	12	су	Mulch	3" Depth (Native Hardwood Mulch)	
Cynodon dactylon 'Tif 419' / Bermuda Grass	3,122	sf		Cynodon dactylon "TIFWAY 419"	
	347	sy	Turf Sod	Bermuda T419	
	39	су	Top Soil	4" Depth (75% Chocolate Loam / 25% Compost)	
MISCELANEOUS					
NAME	TOTAL	UNITS	DESCRIPTION	COMMENTS	
Steel Edging	389	lf	3/16" thick; Green to match existing		
Mulch Bed	1	cy	Double Shredded Hardwood Mulch		
Black Star Gravel	4	cy	3" Depth / Size: 1/2-1" Dia.	Source: Outdoor Warehouse, 2791 S Stemmons Fwy Lewisville, TX 75067	
River Rock	7	cy	4" Depth / Size: 1.5" - 3" Dia., "Austin River Rock"		
IRRIGATION					
SYMB	QTY	UNITS	DESCRIPTION	COMMENTS	
CONTROLLER	1	ea.	Rainbird, Hunter, or Approved Equal		
PLANT BEDS	1,277	s.f.	Drip/Spray		
TREES	10	ea.	Drip/Bubbler	2 per shade tree, 1 per ornamental tree	
SOD/TURF	3.122	s.f.	Drip/Spray/Bubbler		



THE LOCATION OF EXISTING UNDERGROUND UTILITIES ARE HOWN FOR APPROXIMATION ONLY, CONTRACTOR SHALL SHOWN FOR APPROXIMATION ONLY, CONTRACTOR SHALL TERMINE EXACT LOCATION OF ALL EXISTING UTILITIES BEFOR COMMENCING WORK. CONTRACTOR AGREES TO BE FULLY ESSPONSIBLE FOR ANY AND ALL DAMAGES WHICH MIGHT BE CASIONED BY FAILURE TO EXACTLY LOCATE AND PRESERVE AN AND ALL UNDERGROUND UTILITIES. SEC Planning Austin, Texa

LAND PLANN LANDSCAPE ARCHI COMMUNITY BR 3600 W. Parmer L Suite 210

info@secplar extra space s

salt lake city, utah

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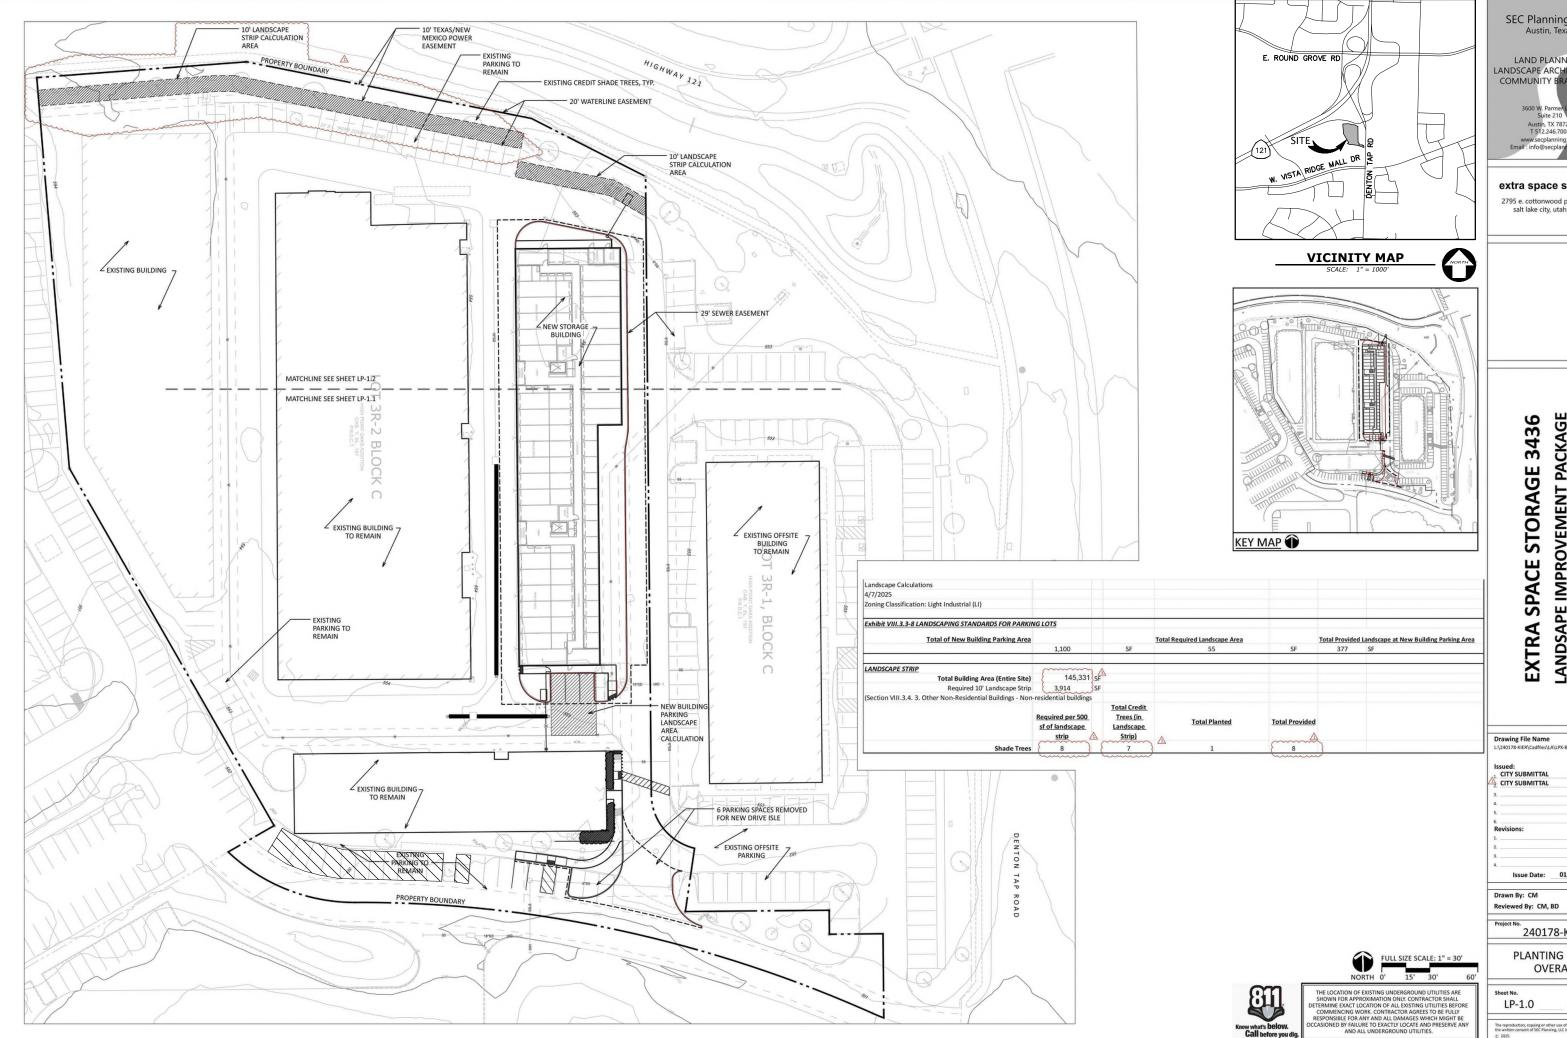
Drawing File Name CITY SUBMITTAL CITY SUBMITTAL

Issue Date: 01 Reviewed By: CM, BD

240178-k

LANDSCAPE

LPN - 1.0



SEC Planning Austin, Texa

LAND PLANN LANDSCAPE ARCHI COMMUNITY BRA

extra space s

2795 e. cottonwood p salt lake city, utah

Drawing File Name

CITY SUBMITTAL CITY SUBMITTAL

Issue Date: 01

Reviewed By: CM, BD

240178-k

PLANTING OVERA



SEC Planning Austin, Texa LAND PLANN LANDSCAPE ARCHI

COMMUNITY BRA 3600 W. Parmer L Suite 210 Austin, TX 7872 T 512.246.700

extra space s

2795 e. cottonwood p salt lake city, utah

LANDSAPE IMPROVEMENT PACKAGE **EXTRA SPACE STORAGE**


CITY SUBMITTAL


Issue Date: 01/

Reviewed By: CM, BD

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PLANTING



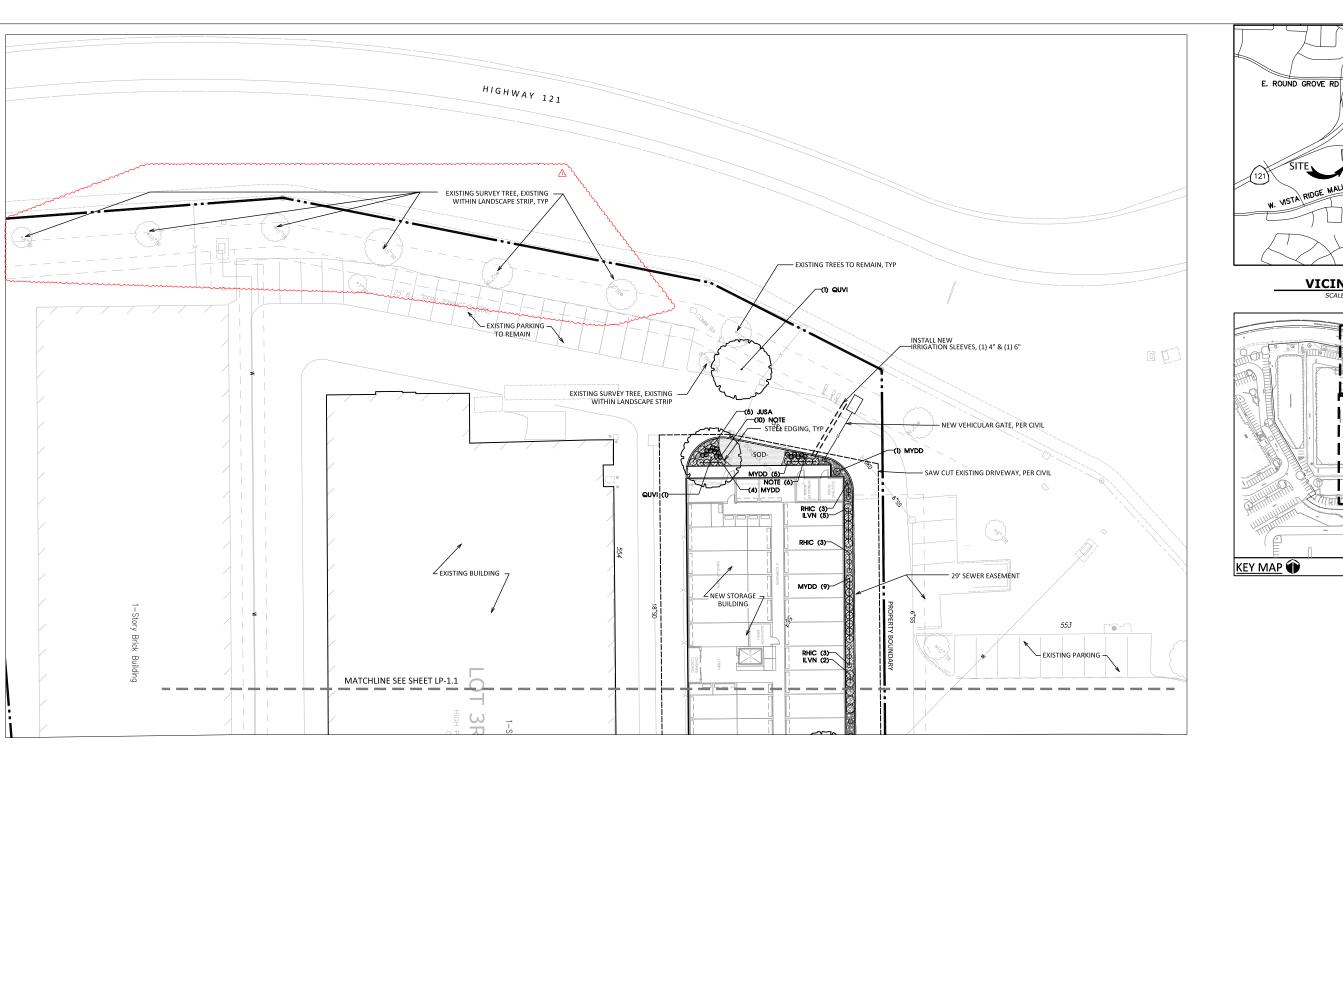

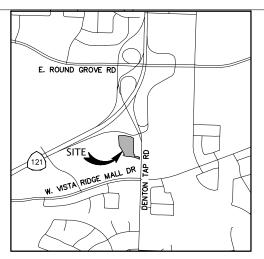SE


LANDS COM


2795 sa

Drawing L:\240178-F

Issued:
CITY S
CITY S



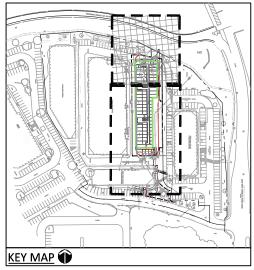

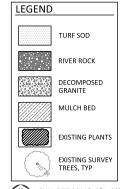

FULL SIZE SCALE: 1" = 20'

NORTH 0' 10' 20'

THE LOCATION OF EXISTING UNDERGROUND UTILITIES ARE SHOWN FOR APPROXIMATION ONLY. CONTRACTOR SHALL